

8

7

6


5

4

3

2

1

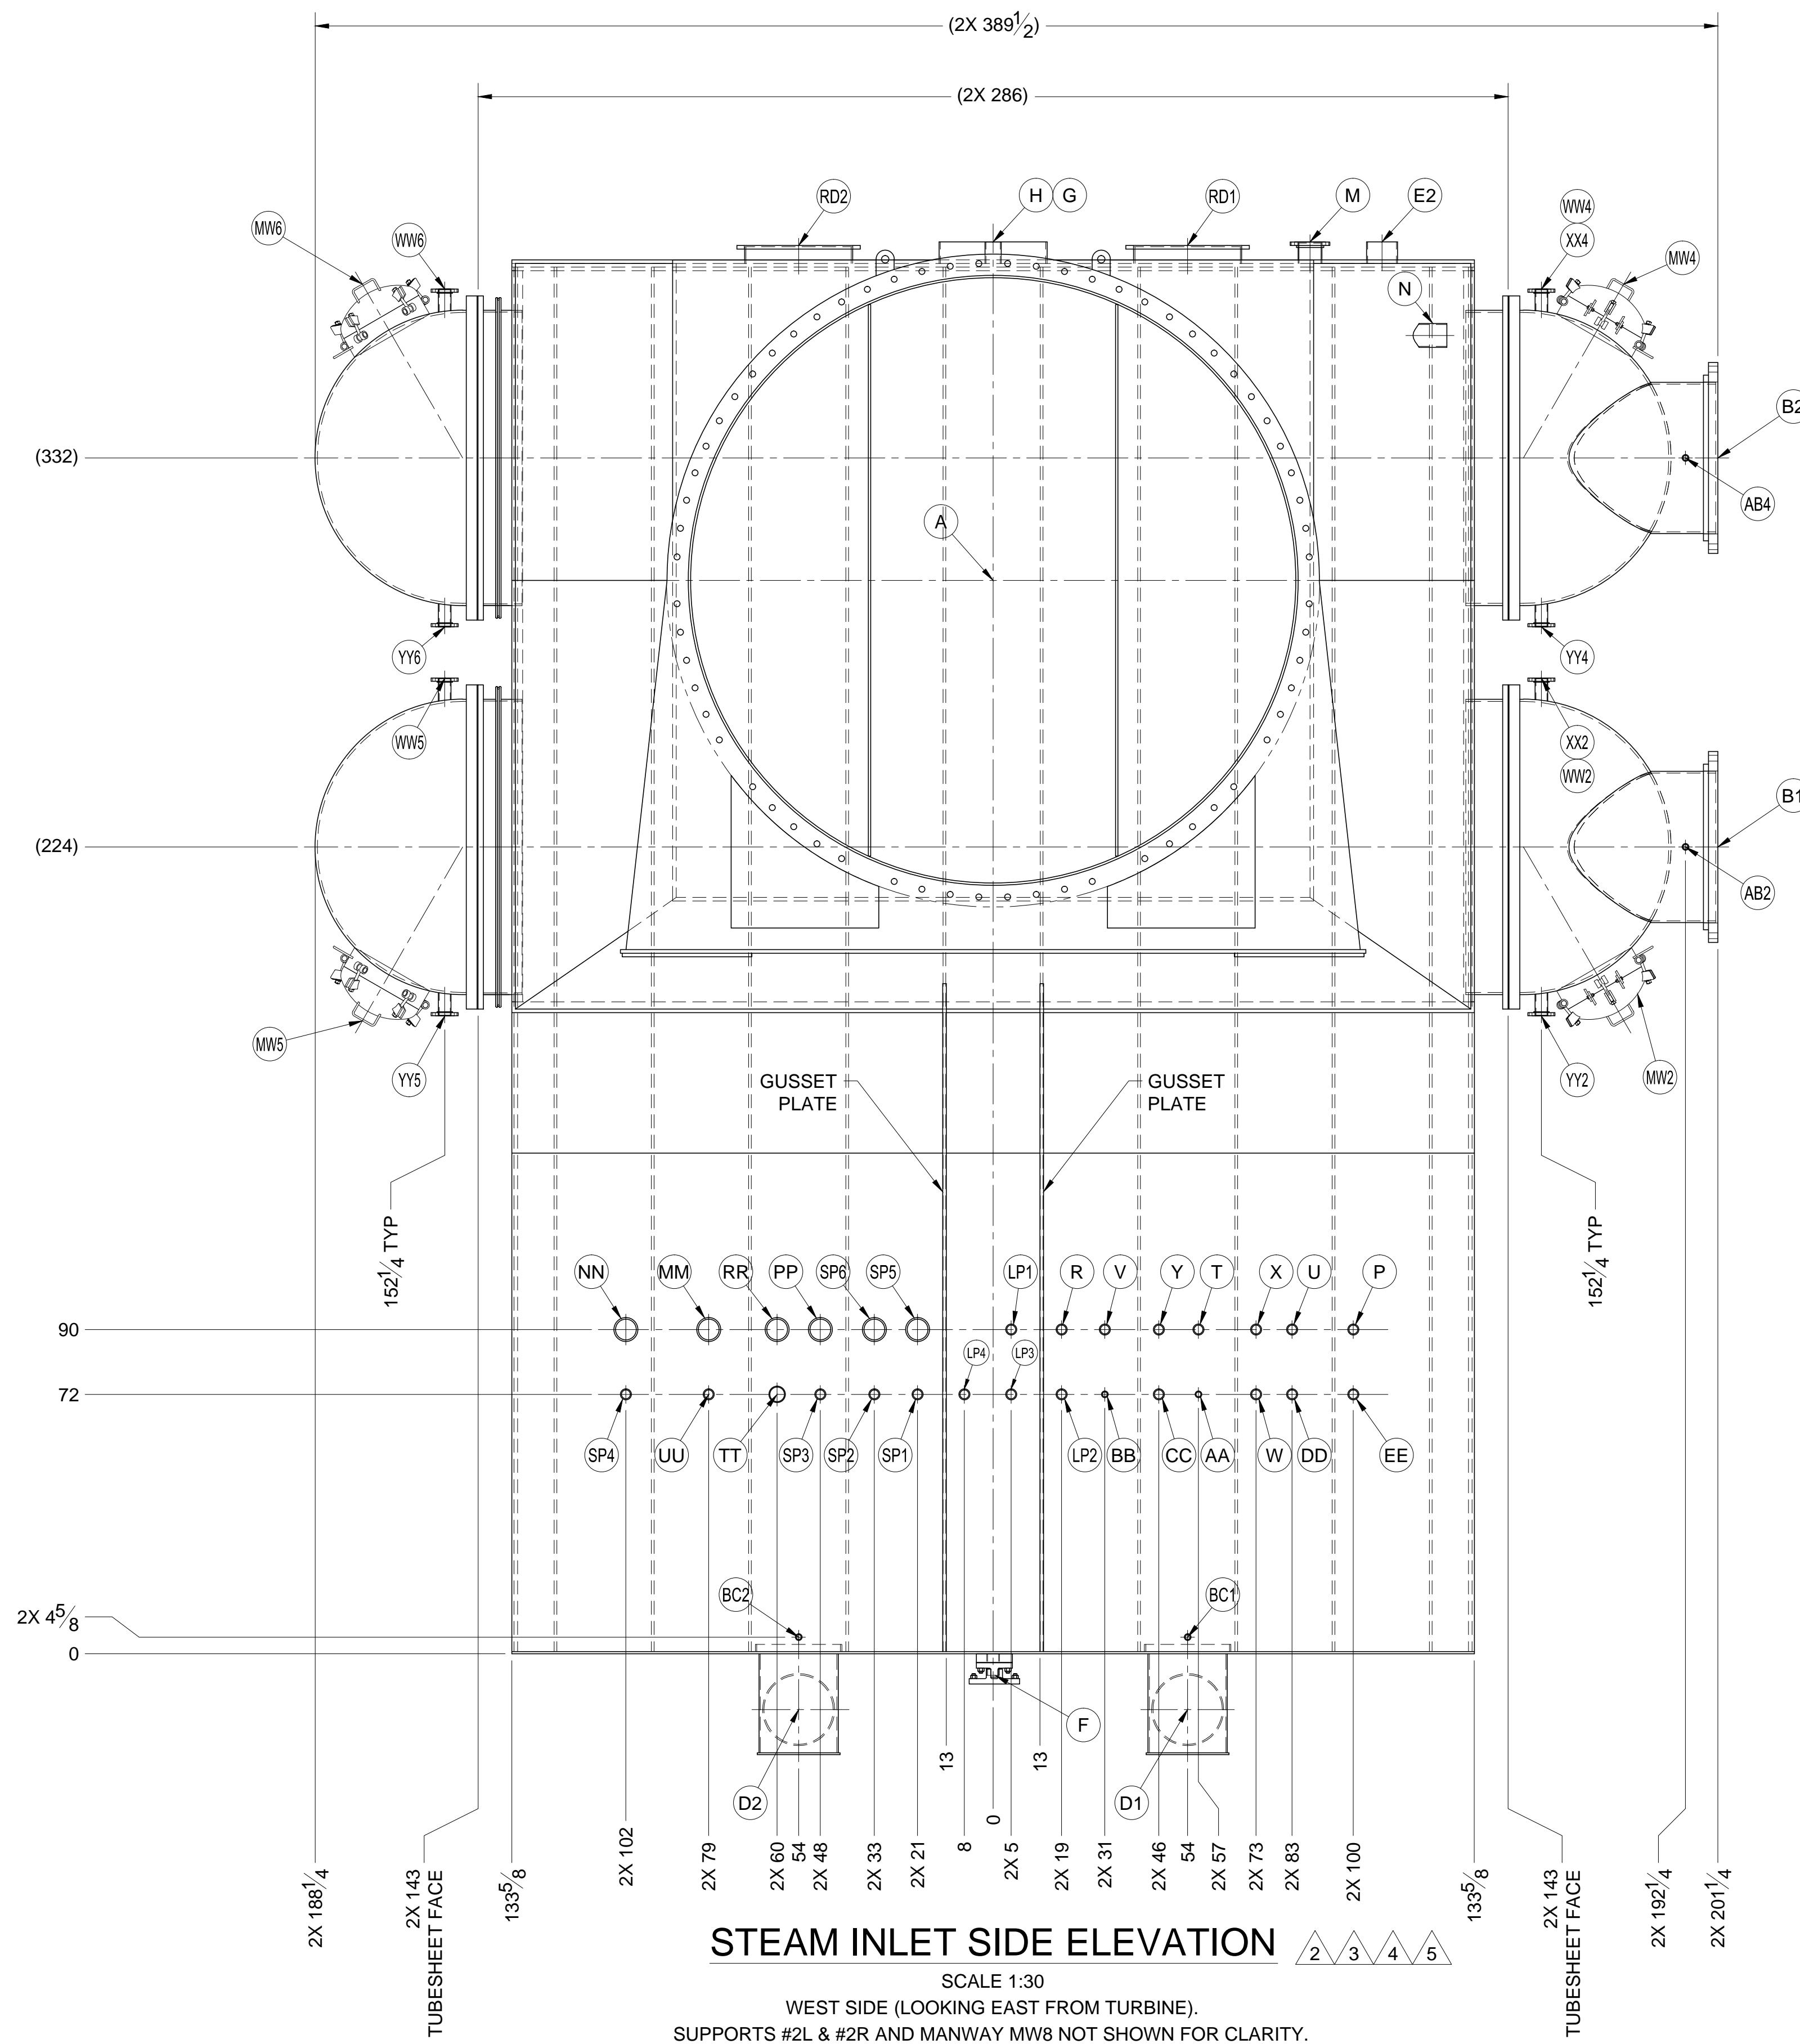

**STEAM INLET SIDE ELEVATION** 2 3 4 5  
 SCALE 1:30  
 WEST SIDE (LOOKING EAST FROM TURBINE).  
 SUPPORTS #2L & #2R AND MANWAY MW8 NOT SHOWN FOR CLARITY.

UNLESS OTHERWISE SPECIFIED  
 ALL DIMENSIONS ARE IN INCHES.  
 BRACKETED [ ] DIMENSIONS ARE IN mm.  
 DO NOT SCALE DRAWING.  
 INTERPRET DIMENSIONING AND  
 TOLERANCING PER ASME Y14.5M-1994.  
 TOLERANCES PER APPLICABLE  
 H.E.I. STANDARD.

REVISION IDENTIFIER  
 NOZZLE IDENTIFIER  
 THIRD ANGLE PROJECTION

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<b>HOLTEC INTERNATIONAL</b> POWER PLANT COMPONENTS DIVISION HOLTEC CENTER 555 LINCOLN DRIVE WEST MARLTON, NJ 08053 (USA)		GAINESVILLE RENEWABLE ENERGY CENTER, FAGEN, INC.	
CLIENT JOB NO. 104009		ENGINEER ZACHRY ENGINEERING CORPORATION	
CLIENT P.O. NO. 554652		LOCATION GAINESVILLE, FLORIDA	
CLIENT DOC. NO. O-A014200-SPCG481116	SIZE D	PROJECT NO. 2135	DRAWING NO. 8284
		SHEET 2 OF 8	REV. 7
FILE PATH: G:\PROJECTS\2135-0-DRAWINGS\GAI\8284_REV 7 PLOTTED July 30, 2012 1:56:51 PM BY TY PETRAKIS			